
LOCUS MAP

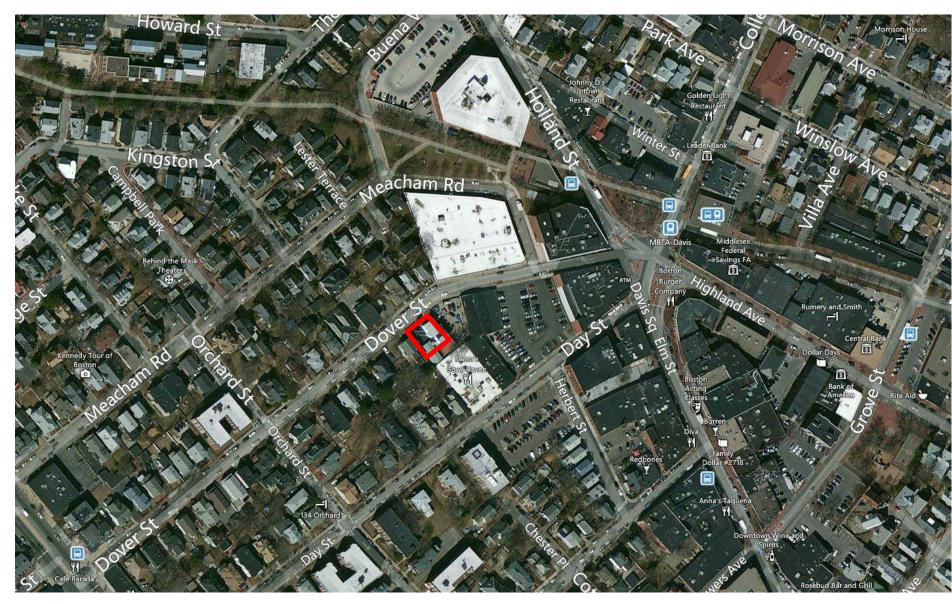



PROPOSED DOVER STREET RESIDENCES 11-20-2015 SUBMISSION

CLIENT Sing Cheung

ARCHITECT
KHALSA DESIGN INC.

17 IVALOO STREET, SUITE 400
SOMERVILLE, MA 02143
T:(617)-591-8682

LANDSCAPE ARCHITECTS

Blair Hines Design Associates, LLC

318 Harvard Street suite 25

Brookline, MA 02446

T: 617-735-1180

F: 617-608-5025

CIVIL ENGINEER

Design Consultants, Inc

PROJECT NAME

DOVER STREET RESIDENCES

PROJECT ADDRESS

88 DOVER STREET SOMERVILLE MA

CLIENT

Sing Cheung

KHALSA DESIGN INC.

ARCHITECT



17 IVALOO STREET SUITE 400 SOMERVILLE, MA 02143 TELEPHONE: 617-591-8682 FAX: 617-591-2086

CONSULTANTS:

REGISTRATION

REGISTRATION


Project number 13007


Project nu	mber	13007	
Date			
Drawn by			
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Scale			
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No.	Description	Date	

Cover Sheet

A-000

DOVER STREET RESIDENCES

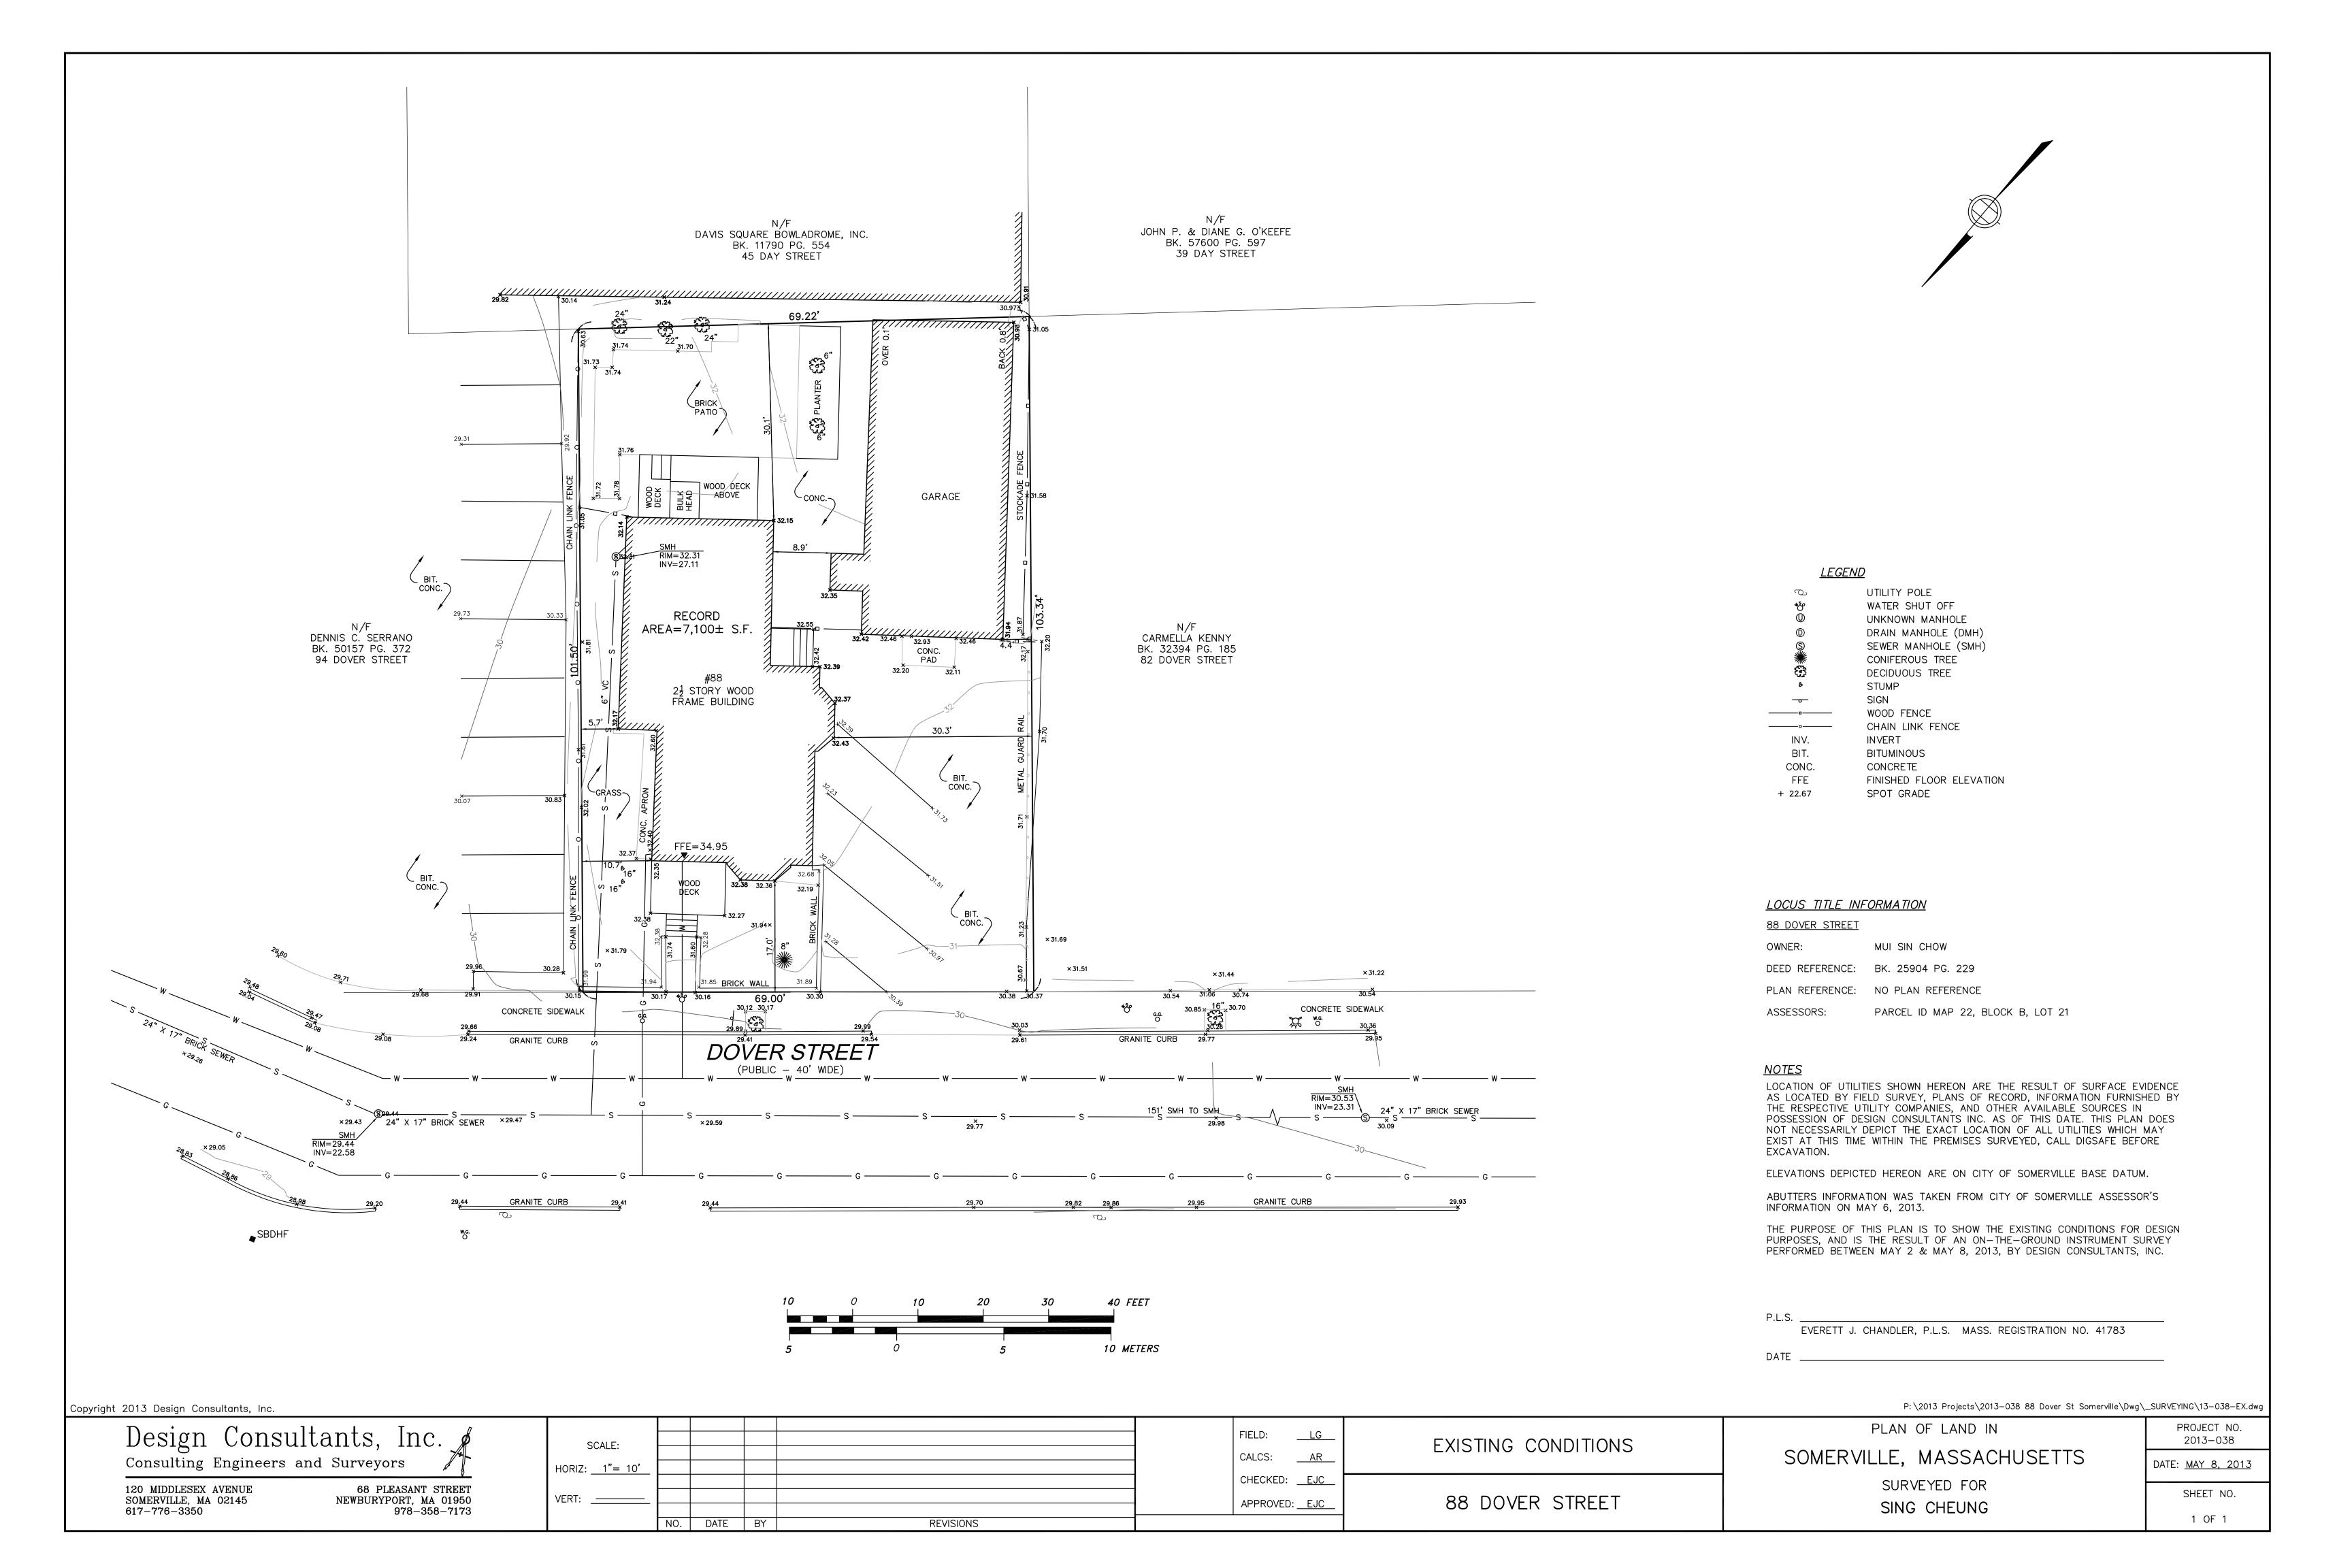

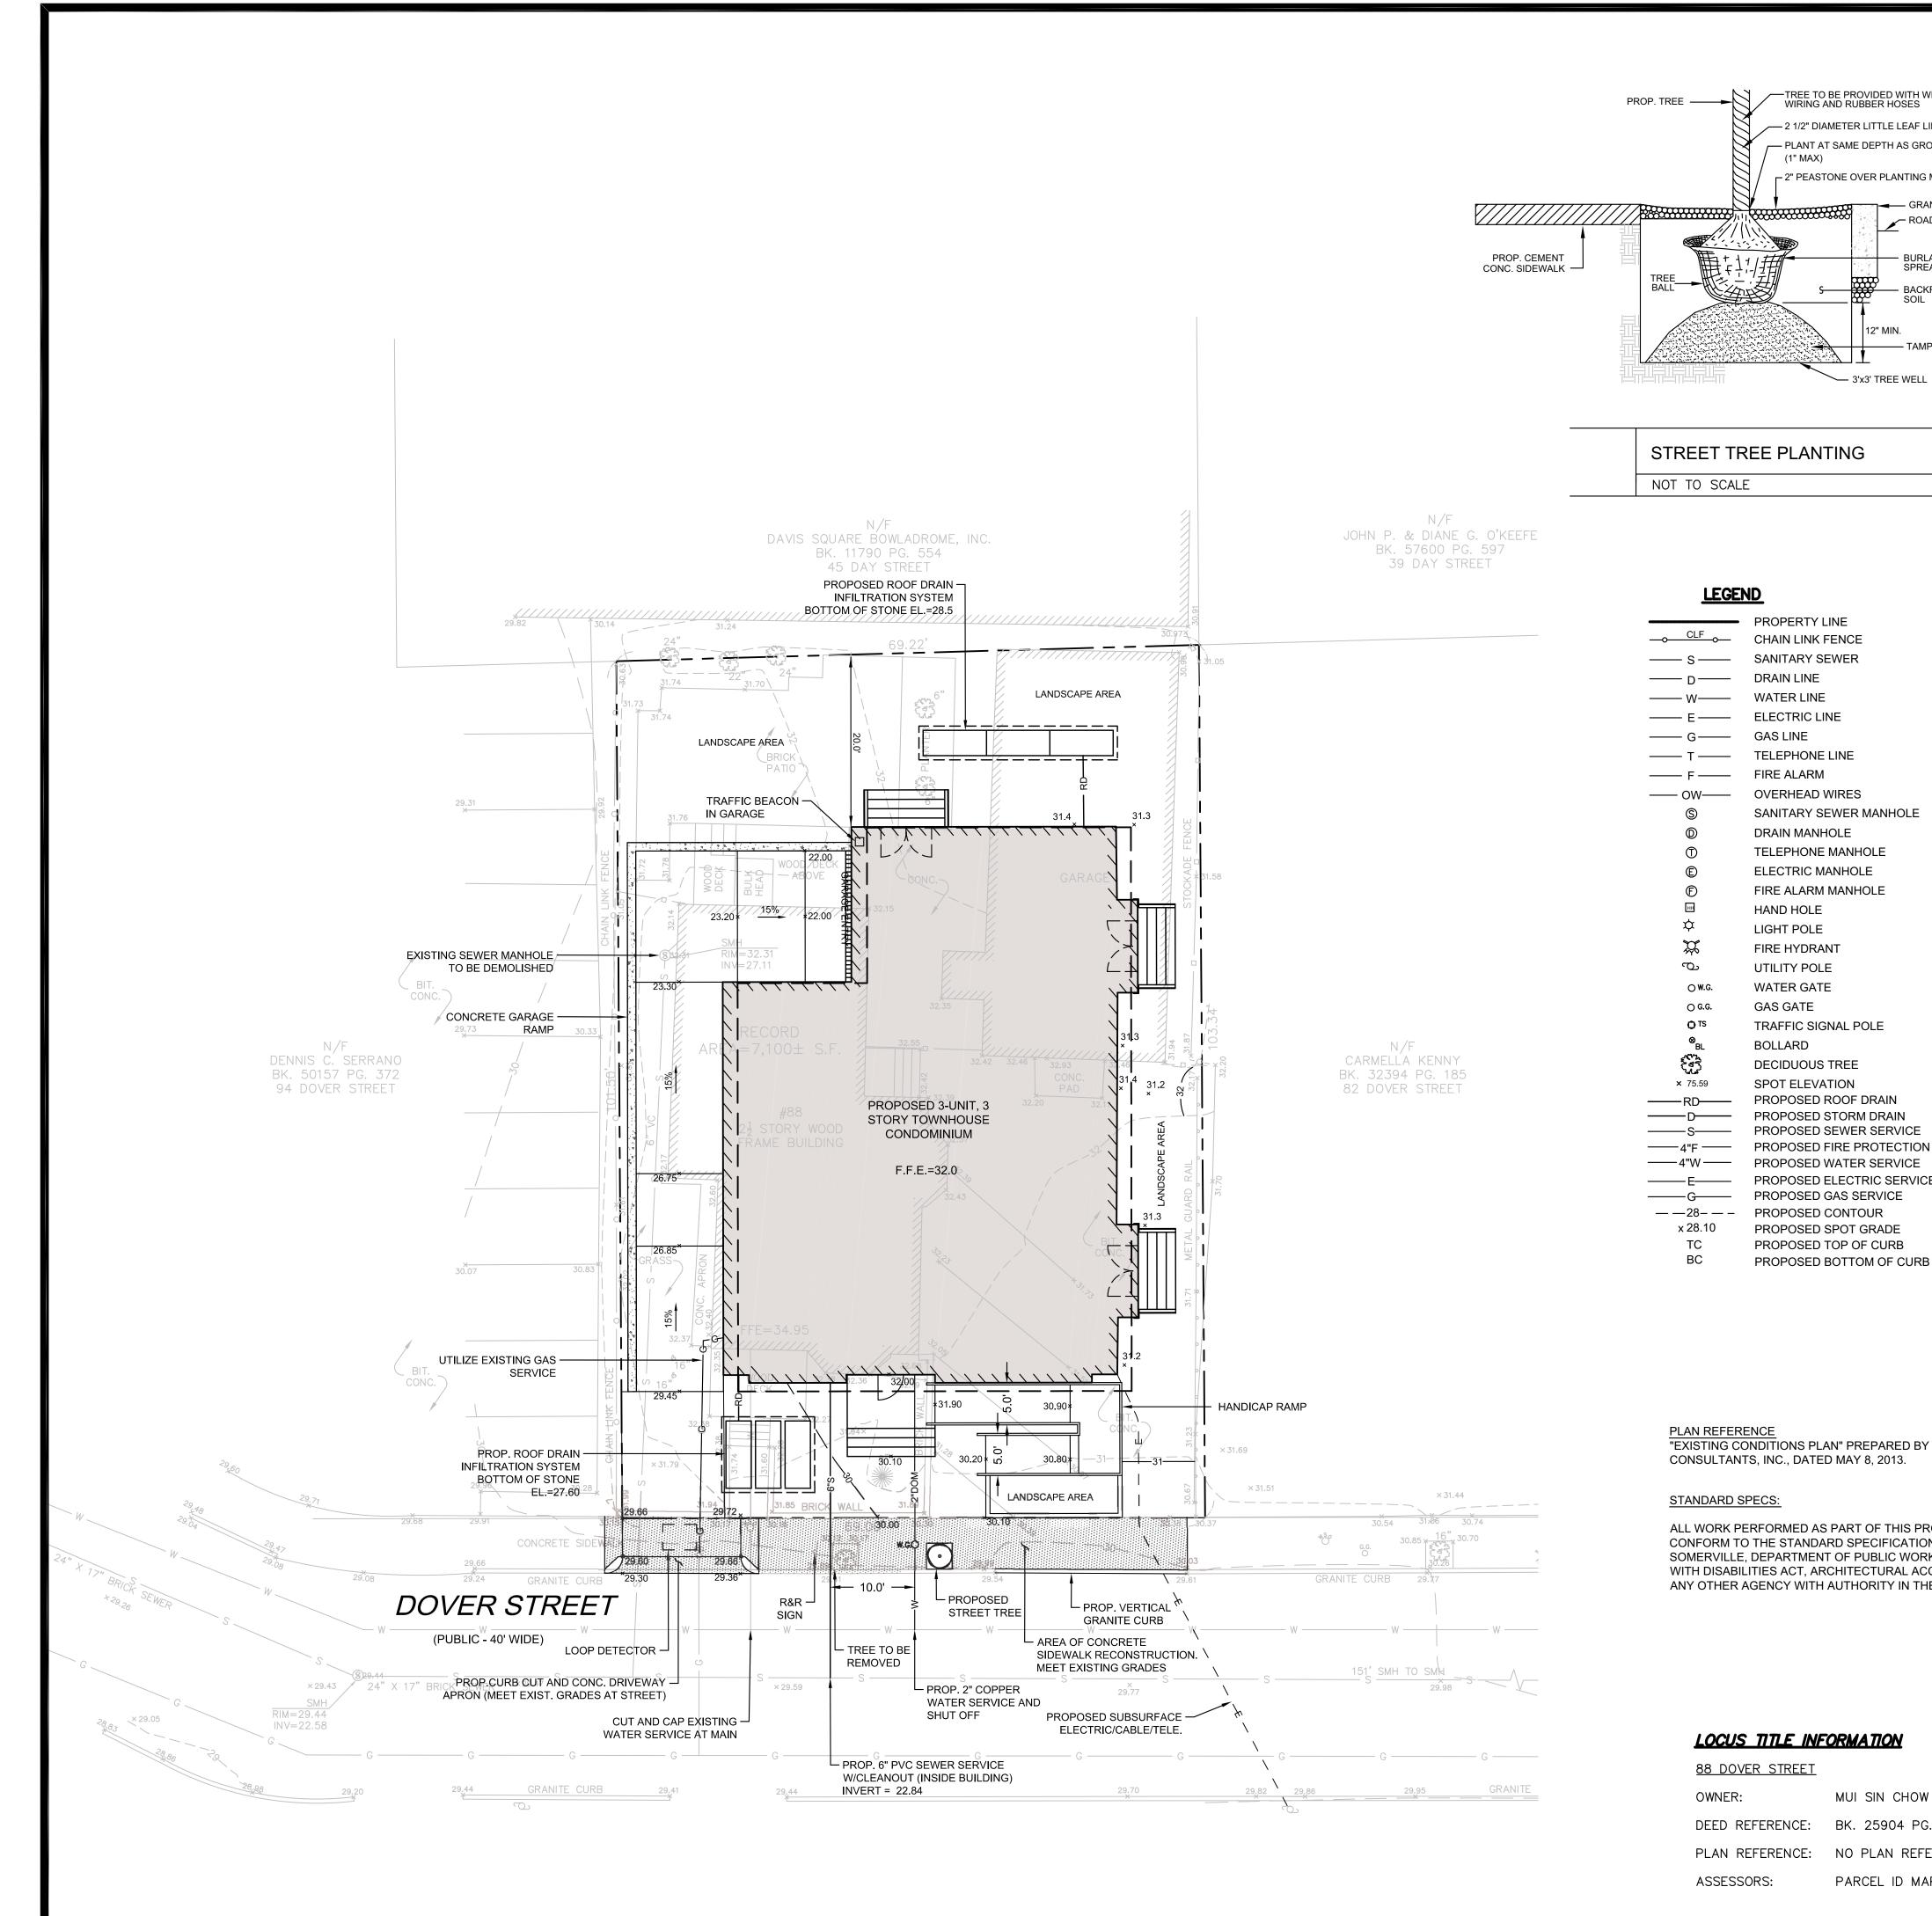




GENERAL NOTES

- 1. THE ADJACENT ABUTTER(S) MUST BE NOTIFIED PRIOR TO ANY CONSTRUCTION LOCATED ON THEIR PROPERTY.
- 2. ALL EXISTING STRUCTURES ON THE SUBJECT PROPERTY SHALL BE DEMOLISHED. UTILITY POLES ARE TO BE REMOVED & RELOCATED BY OTHERS, UNLESS OTHERWISE DIRECTED BY OWNER.
- 3. CONTRACTOR SHALL ADJUST ALL GATES, SERVICE BOXES, ETC. WITHIN ANY RECONSTRUCTION OF THE SIDEWALK AREA.
- 4. SEE LANDSCAPE PLANS FOR TREATMENT AND GRADING OF LANDSCAPE
- 5. GRADES PROVIDED TO MEET ARCHITECT'S LAYOUT.

UTILITY & DRAINAGE NOTES

- 1. THE LOCATION OF AND SIZE OF BURIED UTILITIES ARE THE RESULT OF SURFACE EVIDENCE AS LOCATED BY FIELD SURVEY BY DESIGN CONSULTANTS INC., PLANS OF RECORD & PLANS FROM RESPECTIVE UTILITY COMPANIES.
- 2. THIS PLAN DOES NOT NECESSARILY DEPICT THE EXACT LOCATION AND SIZE OF ALL UTILITIES WHICH MAY EXIST AT THIS TIME INSIDE OR OUTSIDE OF EXISTING OR PROPOSED BUILDINGS, ON THE SUBJECT PROPERTY, WITHIN THE STREET ROW. OR ON ABUTTING LOTS.
- 3. CONTACT DIG-SAFE AT 1-888-344-7233 OR 1-800-322-4844 AT LEAST 72 HOURS PRIOR TO EXCAVATION. THE CITY OF SOMERVILLE MUNICIPAL UTILITIES (WATER, SEWER, & DRAIN) ARE NOT PART OF DIG-SAFE. CONTACT THE CITY OF SOMERVILLE FOR THE MARKING OF SOMERVILLE MUNICIPAL UTILITIES.
- 4. THE LOCATIONS OF EXISTING UNDERGROUND UTILITIES SHOWN ARE APPROXIMATE AND HAVE NOT BEEN INDEPENDENTLY VERIFIED BY THE OWNER OR ITS REPRESENTATIVE. THE CONTRACTOR SHALL FIELD VERIFY THE SIZE AND EXACT LOCATION OF ALL EXISTING UTILITIES BEFORE COMMENCING WORK, AND AGREES TO BE FULLY RESPONSIBLE FOR ANY AND ALL DAMAGES WHICH MIGHT BE OCCASIONED BY THE CONTRACTOR'S FAILURE TO EXACTLY LOCATE AND PRESERVE ANY AND ALL UNDERGROUND UTILITIES.
- 5. ALL EXISTING UTILITY SERVICE CONNECTIONS SHALL BE ABANDONED UNLESS NOTED OTHERWISE. CUTTING AND CAPPING OF DESIGNATED WATER AND SEWER SERVICES SHALL OCCUR AT THE MAIN IN THE STREET, BY THE CONTRACTOR, IN ACCORDANCE WITH THE CITY OF SOMERVILLE STANDARDS. THE PROPOSED GAS, ELECTRIC AND/OR CATV INSTALLATION AND ABANDONMENT OF EXISTING CONNECTIONS SHALL BE COORDINATED BY THE CONTRACTOR WITH THE RESPECTIVE COMPANIES.
- FINAL DEMARCATION POINTS FOR GAS, ELECTRIC, TELEPHONE, AND COMMUNICATION SERVICE ENTRANCES ARE SUBJECT TO APPROVALS OF EACH PROVIDER.
- 7. ALL UTILITIES SHOWN ON THIS SITE ARE TO THE EXTERIOR OF THE BUILDING FOUNDATION ONLY. UTILITIES THROUGH THE FOUNDATION AND INSIDE THE BUILDING ARE THE RESPONSIBILITY OF THE MECHANICAL ENGINEER. SEE MECHANICAL ENGINEERING PLANS.
- 8. THE CONTRACTOR IS RESPONSIBLE FOR VERIFYING AND RECORDING THE EXACT LOCATION OF ALL PROPOSED UTILITY CONNECTIONS.
- 9. NEW WATER SERVICES MUST BE LEFT SHUT OFF AT THE MAIN ON THE STREET UNTIL ACTIVATED BY CITY OF SOMERVILLE.
- 10. TEST PITS WILL BE REQUIRED TO DETERMINE SOIL CLASSIFICATION AND ESTABLISH MEAN HIGH GROUNDWATER ELEVATION PRIOR TO ORDERING AND INSTALLATION OF STORMWATER INFILTRATION SYSTEM COMPONENTS. ADJUSTMENTS TO SYSTEM DESIGNS MAY BE REQUIRED PER TEST RESULTS.
- 11. THE CONTRACTOR SHALL SUPPLY ALL PIPING FOR THE UTILITY SERVICES AND SHALL SUPPLY ALL ASSOCIATED APPURTENANCES, FITTING AND VALVES UNLESS NOTED OTHERWISE. THE CONTRACTOR SHALL PERFORM ALL WET AND DRY TAPS AS PART OF HIS/HER CONTRACT.
- 12. CITY OF SOMERVILLE RESERVES THE RIGHT TO INSPECT ALL FACILITIES DISCHARGING TO THE CITY OF SOMERVILLE DRAIN AND SEWER SYSTEMS. A DYE TEST SHALL BE PERFORMED PRIOR TO THE ISSUANCE OF AN OCCUPANCY PERMIT.
- 13. PRIOR TO CONSTRUCTION OF NEW SANITARY SEWER AND STORM DRAIN LINES, CONTRACTOR SHALL PERFORM TEST PITS AT LOCATIONS OF EXISTING LATERAL CONNECTIONS FOR SANITARY SEWER AND STORM DRAINS TO CONFIRM INVERTS OF LATERALS. ANY DISCREPANCIES ARE TO BE REPORTED TO THE ENGINEER IMMEDIATELY.
- 14. WHERE AN EXISTING UTILITY IS FOUND TO CONFLICT WITH THE PROPOSED WORK, THE LOCATION, ELEVATION AND SIZE OF THE UTILITY SHALL BE ACCURATELY DETERMINED WITHOUT DELAY BY THE CONTRACTOR, AND THE INFORMATION SHALL BE FURNISHED TO THE ENGINEER FOR RESOLUTION OF THE CONFLICT.
- 15. TRENCH AREAS FOR THE CONSTRUCTION OF THE UNDERGROUND UTILITIES ARE TO BE REPATCHED WITH SAME MATERIAL AT THE SAME DEPTH AS THE EXISTING MATERIAL. THE AREAS OF TRENCHING SHALL BE NEATLY SAW-CUT AND THE NEW REPATCHING MATERIAL SHALL BE PROPERLY SEALED IN ACCORDANCE WITH THE CITY OF SOMERVILLE MUNICIPAL STANDARDS.
- 16. DURING EXCAVATION AND CONSTRUCTION OF PIPES AND STRUCTURES, TRENCHES MUST BE ADEQUATELY BRACED AND PROTECTED AGAINST CAVE-IN.
- 17. NO TRENCHES ARE ALLOWED TO REMAIN OPEN OVERNIGHT. ALL TRENCHES SHALL BE BACKFILLED AT THE END OF THE WORK DAY OR COVERED WITH STEEL PLATES PER 520 CMR 14.00 EXCAVATION AND TRENCH SAFETY. IF STEEL PLATES ARE USED, THE TOTAL LENGTH OF PLATES IN THE TRAVELED WAY SHALL LIMITED TO 50'.

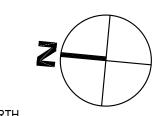

Design Consultants, In 20 Middlesex Avenue, Suite 20 Somerville, MA 02145 617-776-3350p 617-776-7710f

ARCHITECT:

KHALSA DESIGN INC. 17 IVALOO STREET SUITE 400 SOMERVILLE, MA 02143

PROJECT TEAM

88 DOVER STREET

PROJECT INFO

SOMERVILLE, MA 02145

TRAFFIC BEACON & LOOP | 11/20/15 NEW BUILDING REV DESCRIPTION DATE



SITE PLAN

SHEET NAME:

DR BY: CR CHK BY: SBS PROJ NO: 2013-038

DATE: MARCH 19, 2014

SCALE: 1"=10'

LOCUS TITLE INFORMATION

88 DOVER STREET

MUI SIN CHOW DEED REFERENCE: BK. 25904 PG. 229 PLAN REFERENCE: NO PLAN REFERENCE

ASSESSORS: PARCEL ID MAP 22, BLOCK B, LOT 21

TREE TO BE PROVIDED WITH WRAPPING, STAKES, WIRING AND RUBBER HOSES

ROAD SURFACE

BURLAP UNTIED AND

- BACKFILL W/PLANTABLE

— TAMPED PLANTABLE SOIL

SPREAD AWAY FROM BALL

- 2" PEASTONE OVER PLANTING MATERIAL

→ 3'x3' TREE WELL

LEGEND

PROPERTY LINE

CHAIN LINK FENCE

SANITARY SEWER

DRAIN LINE

WATER LINE

ELECTRIC LINE

TELEPHONE LINE

OVERHEAD WIRES

DRAIN MANHOLE

HAND HOLE

LIGHT POLE FIRE HYDRANT

UTILITY POLE

WATER GATE

GAS GATE

BOLLARD

× 75.59

x 28.10

TELEPHONE MANHOLE

ELECTRIC MANHOLE

FIRE ALARM MANHOLE

TRAFFIC SIGNAL POLE

PROPOSED ROOF DRAIN

PROPOSED STORM DRAIN

PROPOSED GAS SERVICE

PROPOSED SPOT GRADE

PROPOSED TOP OF CURB

"EXISTING CONDITIONS PLAN" PREPARED BY DESIGN

ALL WORK PERFORMED AS PART OF THIS PROJECT SHALL

ANY OTHER AGENCY WITH AUTHORITY IN THE AREA.

CONFORM TO THE STANDARD SPECIFICATIONS OF THE CITY OF

SOMERVILLE, DEPARTMENT OF PUBLIC WORKS, THE AMERICAN'S WITH DISABILITIES ACT, ARCHITECTURAL ACCESS BOARD, AND

CONSULTANTS, INC., DATED MAY 8, 2013.

STANDARD SPECS:

PROPOSED BOTTOM OF CURB


PROPOSED ELECTRIC SERVICE

DECIDUOUS TREE

SPOT ELEVATION

SANITARY SEWER MANHOLE

— 2 1/2" DIAMETER LITTLE LEAF LINDEN

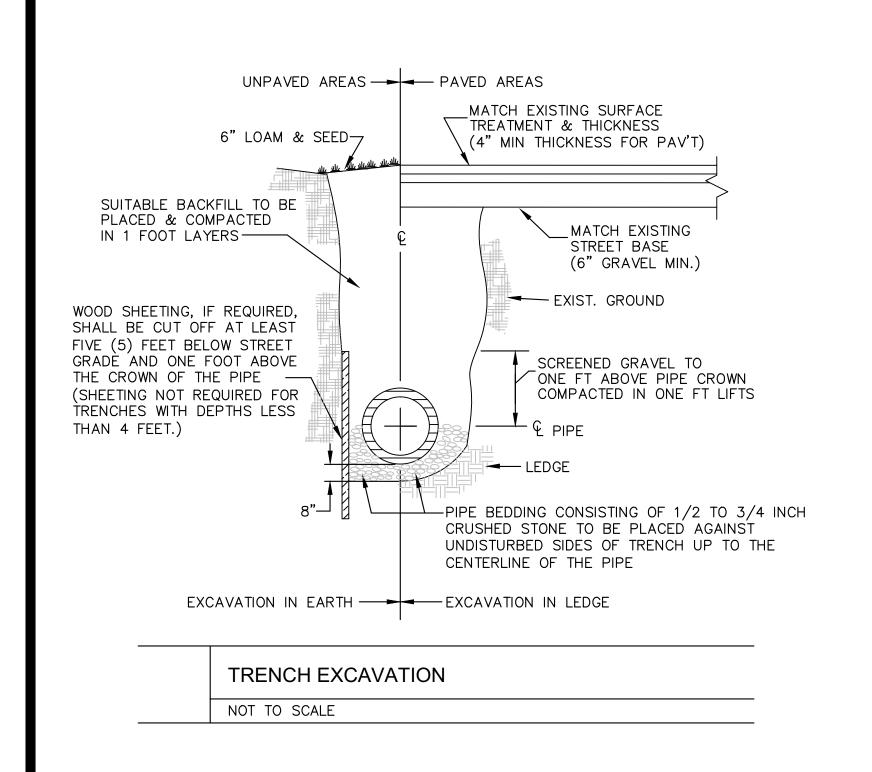

PVC CLEANOUT PLUG —


CEMENT CONCRETE

SUPPORT COLLAR -

POUR IN-PLACE - 3000 PSI

3/4" CRUSHED STONE OR SCREENED GRAVEL -


6" PVC VERTICAL PIPE & FITTINGS LENGTH TO SUIT APPLICATION —

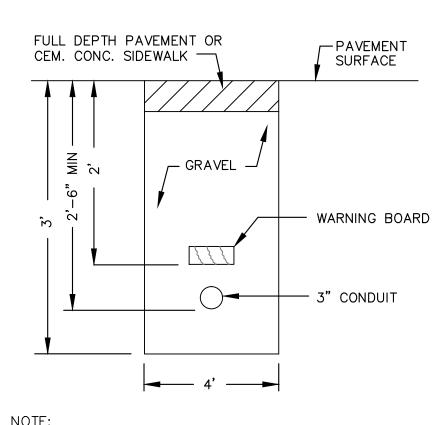

NOTE:


1. SEE ELECTRICAL DRAWINGS FOR FURTHER DETAIL

CONDUIT
NOT TO SCALE

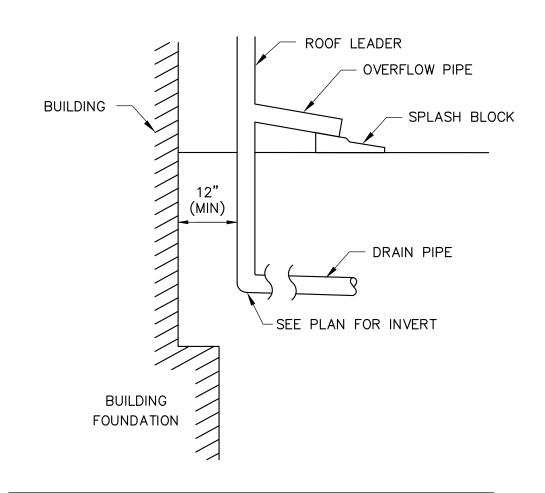

DOWNSPOUT OVERFLOW

NOT TO SCALE

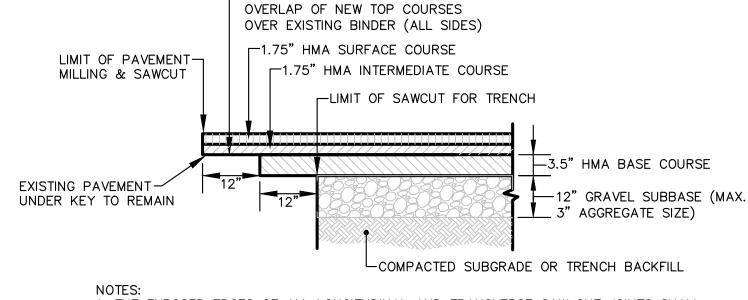


MILL PAVEMENT TO ALLOW FOR 12"

NOTES:

1. THE EXPOSED EDGES OF ALL LONGITUDINAL AND TRANSVERSE SAW CUT JOINTS SHALL BE TREATED WITH HOT POURED RUBBERIZED ASPHALT JOINT SEALANT MEETING MASSDOT SPECIFICATIONS.


2. FOR ROADS WITH AN EXISTING CEMENT CONCRETE BASE, A REINFORCED, HIGH EARLY STRENGTH AIR ENTRAINED, CLASS "F" CEMENT CONCRETE SLAB SHALL BE CAST IN PLACE TO MEET THE EXISTING PAVEMENT. SPECIFIC JOINT DETAILS WITH THE EXISTING PAVEMENT SHALL BE APPROVED DEPENDENT ON THE EXISTING SITE CONDITIONS.



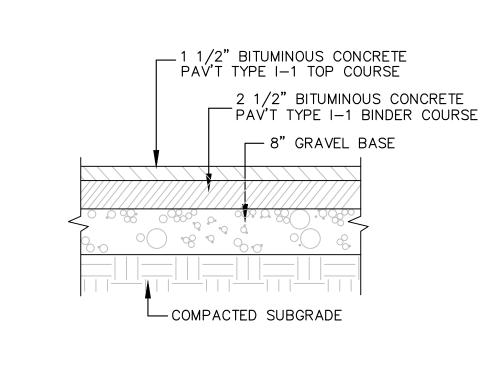

NOT TO SCALE

BITUMINOUS CONCRETE PAVEMENT

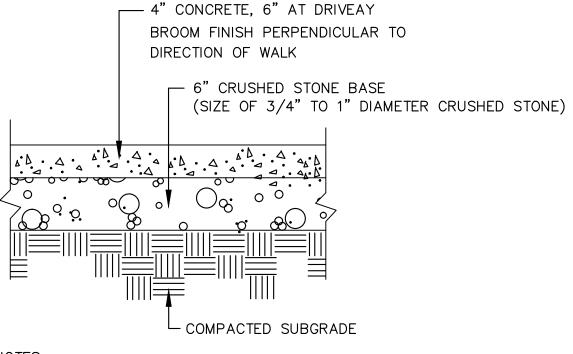


NOTES:

- 1. PROVIDE 1/2" CONSTRUCTION CONTROL JOINT WITH PREFORMED EXPANSION MATERIAL EVERY 10'-0" O.C. MAX.
- 2. PROVIDE A TOOLED DUMMY JOINT 1/4"W x 1/2"D AS NEEDED TO PROVIDE SYMMETRY.
- 3. CONCRETE TO BE 4,000 PSI STRENGTH.


CEMENT CONCRETE SIDEWALK

NOT TO SCALE

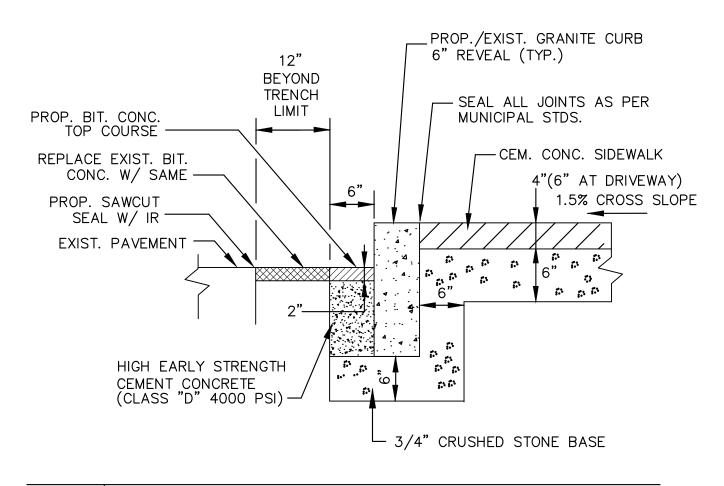

GRANITE CURB IN EXISTING ROAD
PAVEMENT W/ NEW SIDEWALK

NOT TO SCALE

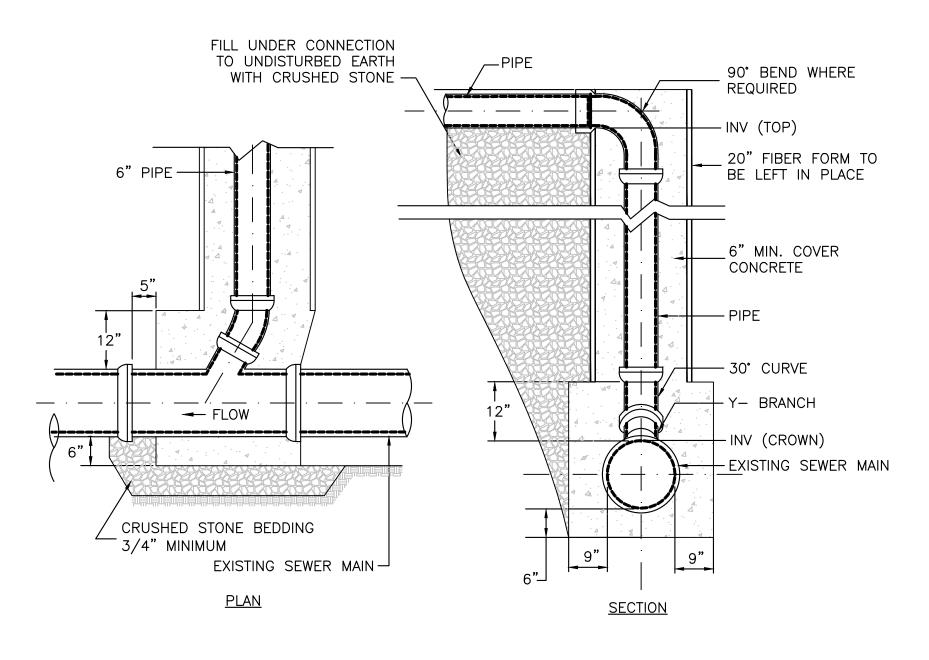

__E. L. LEBARON FOUNDRY, INC.

(LONG SWEEP)

DIAMETER TO MATCH BUILDING SEWER

SEWER CLEANOUT

NOT TO SCALE


CATALOG NO. LA0910 SEWER

CLEANOUT RING & COVER OR EQUAL

1. SEE SHEET 1 FOR SERVICE CONNECTION SIZES


SEWER/STORMWATER SERVICE CHIMNEY CONNECTION

NOT TO SCALE

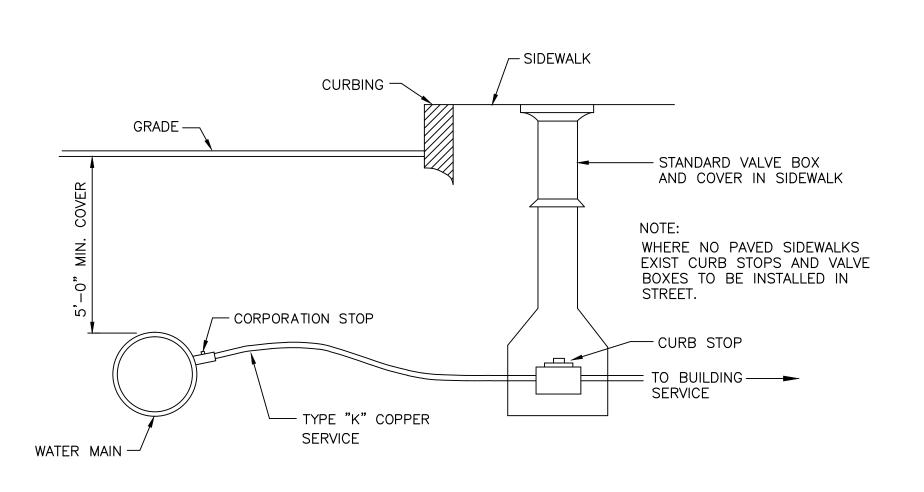

COPPER SERVICE CONNECTION

NOT TO SCALE

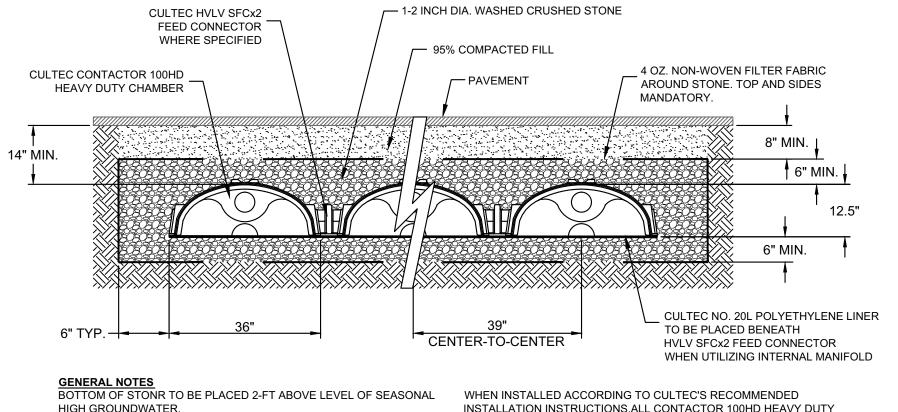

BOTTOM OF STONR TO BE PLACED 2-FT ABOVE LEVEL OF SEASONAL HIGH GROUNDWATER.

CONTACTOR 100HD BY CULTEC, INC. OF BROOKFIELD, CT.

STORAGE PROVIDED = 3.84 CF/FT PER DESIGN UNIT.

REFER TO CULTEC, INC.'S CURRENT RECOMMENDED INSTALLATION GUIDELINES.

MAXIMUM ALLOWED COVER ON TOP OF UNIT SHALL BE 12.0' [3.66m]

THE CHAMBER WILL BE DESIGNED TO WITHSTAND TRAFFIC LOADS

WHEN INSTALLED ACCORDING TO CULTEC'S RECOMMENDED INSTALLATION INSTRUCTIONS.ALL CONTACTOR 100HD HEAVY DUTY UNITS ARE MARKED WITH A COLOR STRIPE FORMED INTO THE PART ALONG THE LENGTH OF THE CHAMBER. ALL CONTACTOR 100 CHAMBERS MUST BE INSTALLED IN ACCORDANCE WITH ALL APPLICABLE LOCAL, STATE AND FEDERAL REGULATIONS.

TYPICAL INFILTRATION/DETENTION SYSTEM

NOT TO SCALE

NORTH

Design Consultants, In CIVIL ENGINEERS and LAND SURVEYORS 120 Middlesex Avenue, Suite 20 Somerville, MA 02145 617-776-3350p 617-776-7710f

ARCHITECT:

KHALSA DESIGN INC. 17 IVALOO STREET SUITE 400 SOMERVILLE, MA 02143

PROJECT TEAM

8 CURTIS STREET

SOMERVILLE, MA 02145

PROJECT INFO

DESCRIPTION



DATE

STAMP:

DETAILS

SHEET NAME:

C-2

HT NO:

DR BY: CR CHK BY: SBS

PROJ NO: 2013-146


DATE: MARCH 18, 2014

SCALE: N.T.S.

PLANT LIST COMMON NAME SIZE KEY QTY LATIN NAME **NOTES TREES** QR Red Oak 3-3.5" cal. B&B Quercus rubra 2.5"-3" cal B&B SR Syringa reticulata 'Ivory Silk' Tree Lilac Thuja occendentalis 'Smaragd' B&B TO Emerald Green Arborvitae 5-6' ht. Thuja plicata 'Green Giant' TP B&B Green Giant Western Red Cedar 7-8' ht. SHRUBS/VINES CA 3 Clethra alnifolia 'Hummingbird' **Hummingbird Summersweet** 3' ht. **Green Threadleaf Cypress** 4-5' ht. B&B CP Chamaecyparis pisifera Mops Threadleaf Cypress 24" ht. CPf 3 Chamaecyparis pisifera 'Filifera Mops' Clematis virginiana Virgin's Bower Vine CV 3 gal. pot Mophead Hydrangea 30" ht. Hydrangea macrophylla Pink Dwarf Spiraea Spiraea japonica 'Little Princess' 2 gal. Syringa patula 'Miss Kim' SP 36-48" ht 3 Miss Kim Lilac Viburnum plicatum tomentosa Doublefile Vib. 48" ht. PERENNIALS/GRASSES Mountain Pink Creeping phlox Phlox subulata 'Emerald Cushion Pink' I gal Vinca minor 18" o.c. I gal

PLANTING NOTES


- All plant material shall be approved by the Landscape Architect prior to arrival on the site.
- All plant material shall conform to the guidelines established by "The American Standard for Nursery Stock", published by the American Association of Nurserymen, Inc.
- No substitution of plant species will be allowed without the written approval of the Landscape Architect. Any proposed substitutions of plant species shall be a plant of equivalent overall form, height and branching habit, flower, leaf and fruit, color and time of bloom.
- The Contractor shall locate and verify all utility line locations prior to staking and report any conflicts to the Landscape Architect.
- All plants shall be staked out in their approximate location by the Contractor. The Contractor shall adjust the locations of these stakes as required by the Landscape Architect to account for subsurface utilities, other field conditions and to achieve design intent. Final locations must be approved by the Landscape Architect prior to planting.
- No planting shall be installed before acceptance of rough grading of topsoil.
- The rootballs of trees shall be planted 3" above adjacent finished grade. Excavate holes no deeper than the rootball of trees. Holes shall be at least 3' greater in diameter than root ball. Backfill planting hole with 'planting mix'. All plants which settle out of plumb or below finished grade shall be immediately replanted.
- The rootballs of shrubs shall be planted 2" above adjacent finished grade. Excavate holes no deeper than the rootball of shrubs.
- All shrubs, groundcovers and perennials shall be planted in continuous planting beds. All beds shall be excavated 12" and the topsoil and subsoil set aside for reuse. Remove all stone and debris from excavated soil. Backfill beds with 12" of 'planting mix' before planting shrubs, perennials and groundcovers.
- 'Planting Mix' shall consist of 2 parts of topsoil saved from site excavations and I part compost. Thoroughly mix to create uniform blended mixture. If insufficient topsoil is available on the site, mix existing soil in a ratio of I part soil to I part compost. Remove all stones and debris larger than 2" from planting mix.
- All beds as shown on the drawings shall be edged with a 4" trench neatly cut and backfilled with bark mulch. All beds shall be covered with no less than 2"depth settled bark mulch and no greater than 3" depth bark
- All planting to be done under the full time supervision of a certified arborist, nurseryman or licensed Landscape Architect.
- All plants are to be thoroughly watered after installation, at least twice within the first 24 hours.

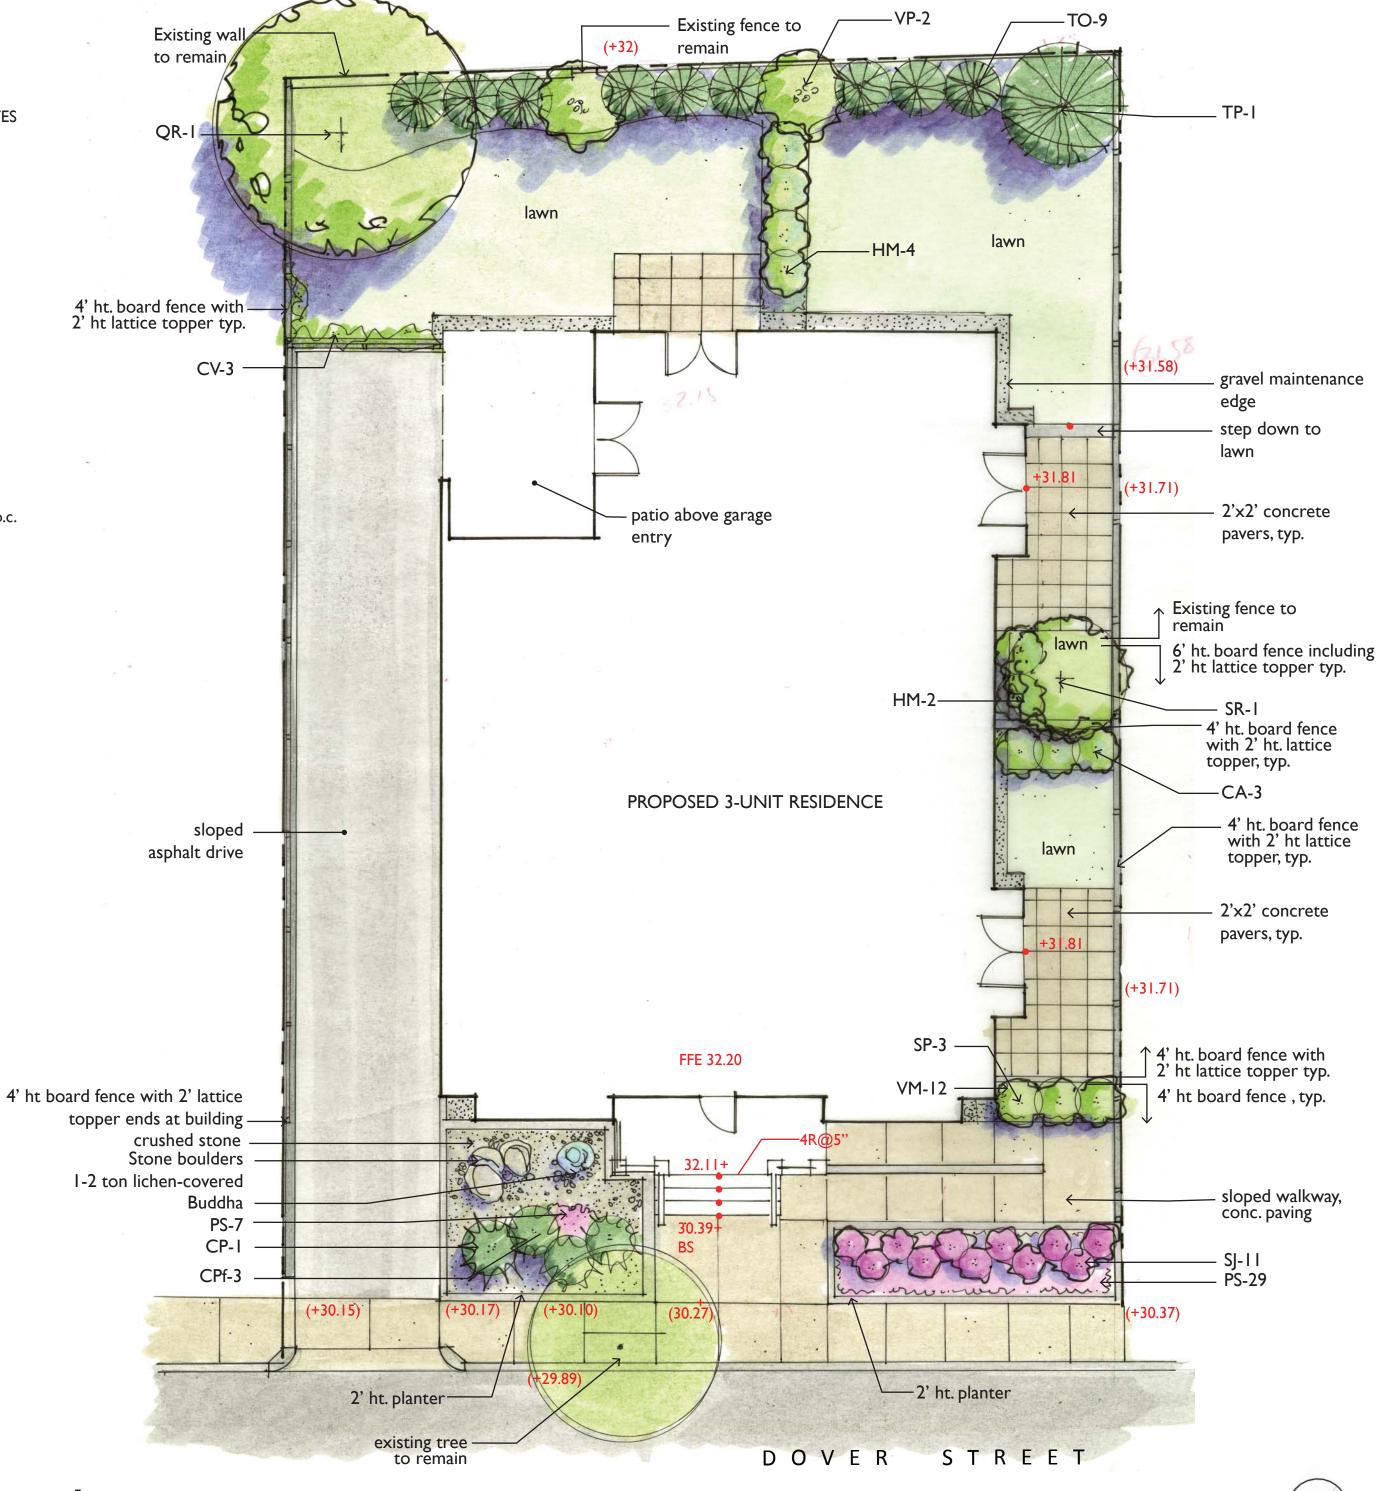



88 Dover Street Residences

Landscape Plan

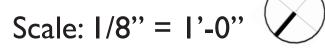





Granite paver



Permeable paver - 8" Square



Horizontal board fence



Equisetum





stone



Hakonechloa

Japanese painted fern







Coral Bells



'Karl Foerster' feather reed grass Red Yucca





Weeping Alaskan Cedar



Ginkgo




Blair Hines Design 88 Dover Street Residences




17 IVALOO STREET SUITE 400 SOMERVILLE, MA 02143 TELEPHONE: 617-591-8682 FAX: 617-591-2086

CONSULTANTS:

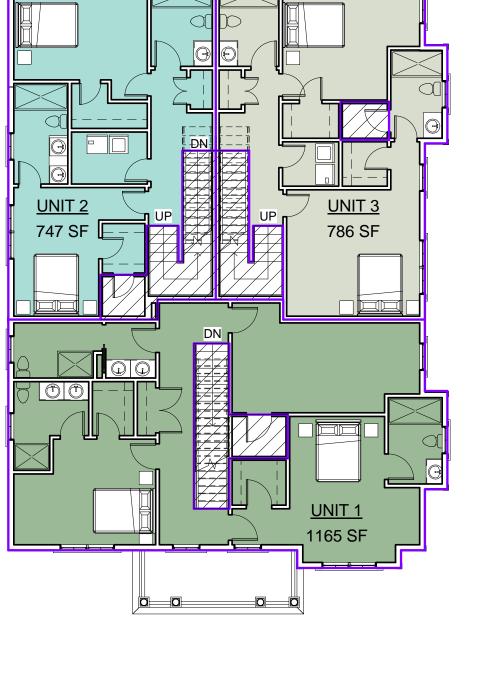

4 SECOND FLOOR LEVEL 3/32" = 1'-0"

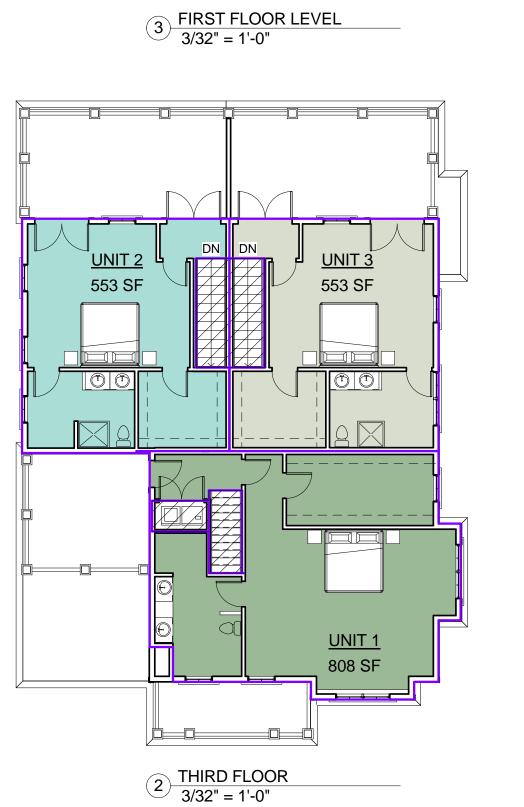

DN

ZONING DIMENSIONAL TABLE

ZONE

MIN. LOT SIZE

LANDSCAPE AREA

FLOOR AREA RATIO

MIN YARD FRONT

MIN FRONTAGE

PERVIOUS AREA

BICYCLE PARKING

i,

<u>UNIT 2</u>

MAX BUILDING HEIGHT

REAR

PARKING REQUIREMENTS 2 PER / DU

MIN LOT PER DWELLING

MAX GROUND COVERAGE 50%

USE

REQUIRED

RB ZONE

7,500 SF

25%

1.0

15'-0"

10'-0"

20'-0"

50'-0"

35%

AREAS NOT INCLUDED IN F.A.R. CALCULATIONS

UNIT 3

789 SF

1 PER / DU

2/3 FAMILY

1500 SF/DU

40'-0" / 3ST

EXISTING

1,348 SF (19%)

1,177 SF (16%)

1,177 SF (16%)

UNKNOWN

UNKNOWN

30'-3" (R)

2 FAMILY

7,100 SF

2,445 SF

32'-0"

17'-0"

30'-0"

69'-0"

5'-7" (L)

PROPOSED

3 FAMILY

7,075 SF

.99

15'-0"

21'-0"

69'-0"

2,366 SF/DU

3,068 SF (43%)

2,457 SF (35%)

2,457 SF (35%)

3 - WALL RACKS

10'-0" (L) 10'-0" (R)

COMPLIES

COMPLIES

COMPLIES

COMPLIES

COMPLIES

36'-3" / 3ST

	Area Schedule F	AR
wt	Level	Area
rea	FIRST FLOOR LEVEL	208 SF
пеа	FIRST FLOOR LEVEL	208 SF
JNIT 1	FIRST FLOOR LEVEL	619 SF
JNIT 1	SECOND FLOOR LEVEL	1165 SF
JNIT 1	THIRD FLOOR	808 SF
		2592 SF
JNIT 2	FIRST FLOOR LEVEL	847 SF
JNIT 2	SECOND FLOOR LEVEL	747 SF
JNIT 2	THIRD FLOOR	553 SF
		2147 SF
JNIT 3	FIRST FLOOR LEVEL	789 SF
JNIT 3	SECOND FLOOR LEVEL	786 SF
JNIT 3	THIRD FLOOR	553 SF
		2128 SF
Frand total	al: 10	7075 SF


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CLIENT

Sing Cheung

KHALSA DESIGN INC.




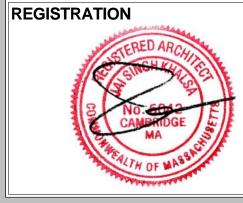

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Project	number	13007	
Date		10-14-15	
Drawn I	by	WC/CMH	
Checke	ed by	KDI	
Scale		As indicated	
REVIS	SIONS		
No.	Description	Date	
			-
			-
			=
		1	- 11

SITE PLAN

DOVER STREET RESIDENCES

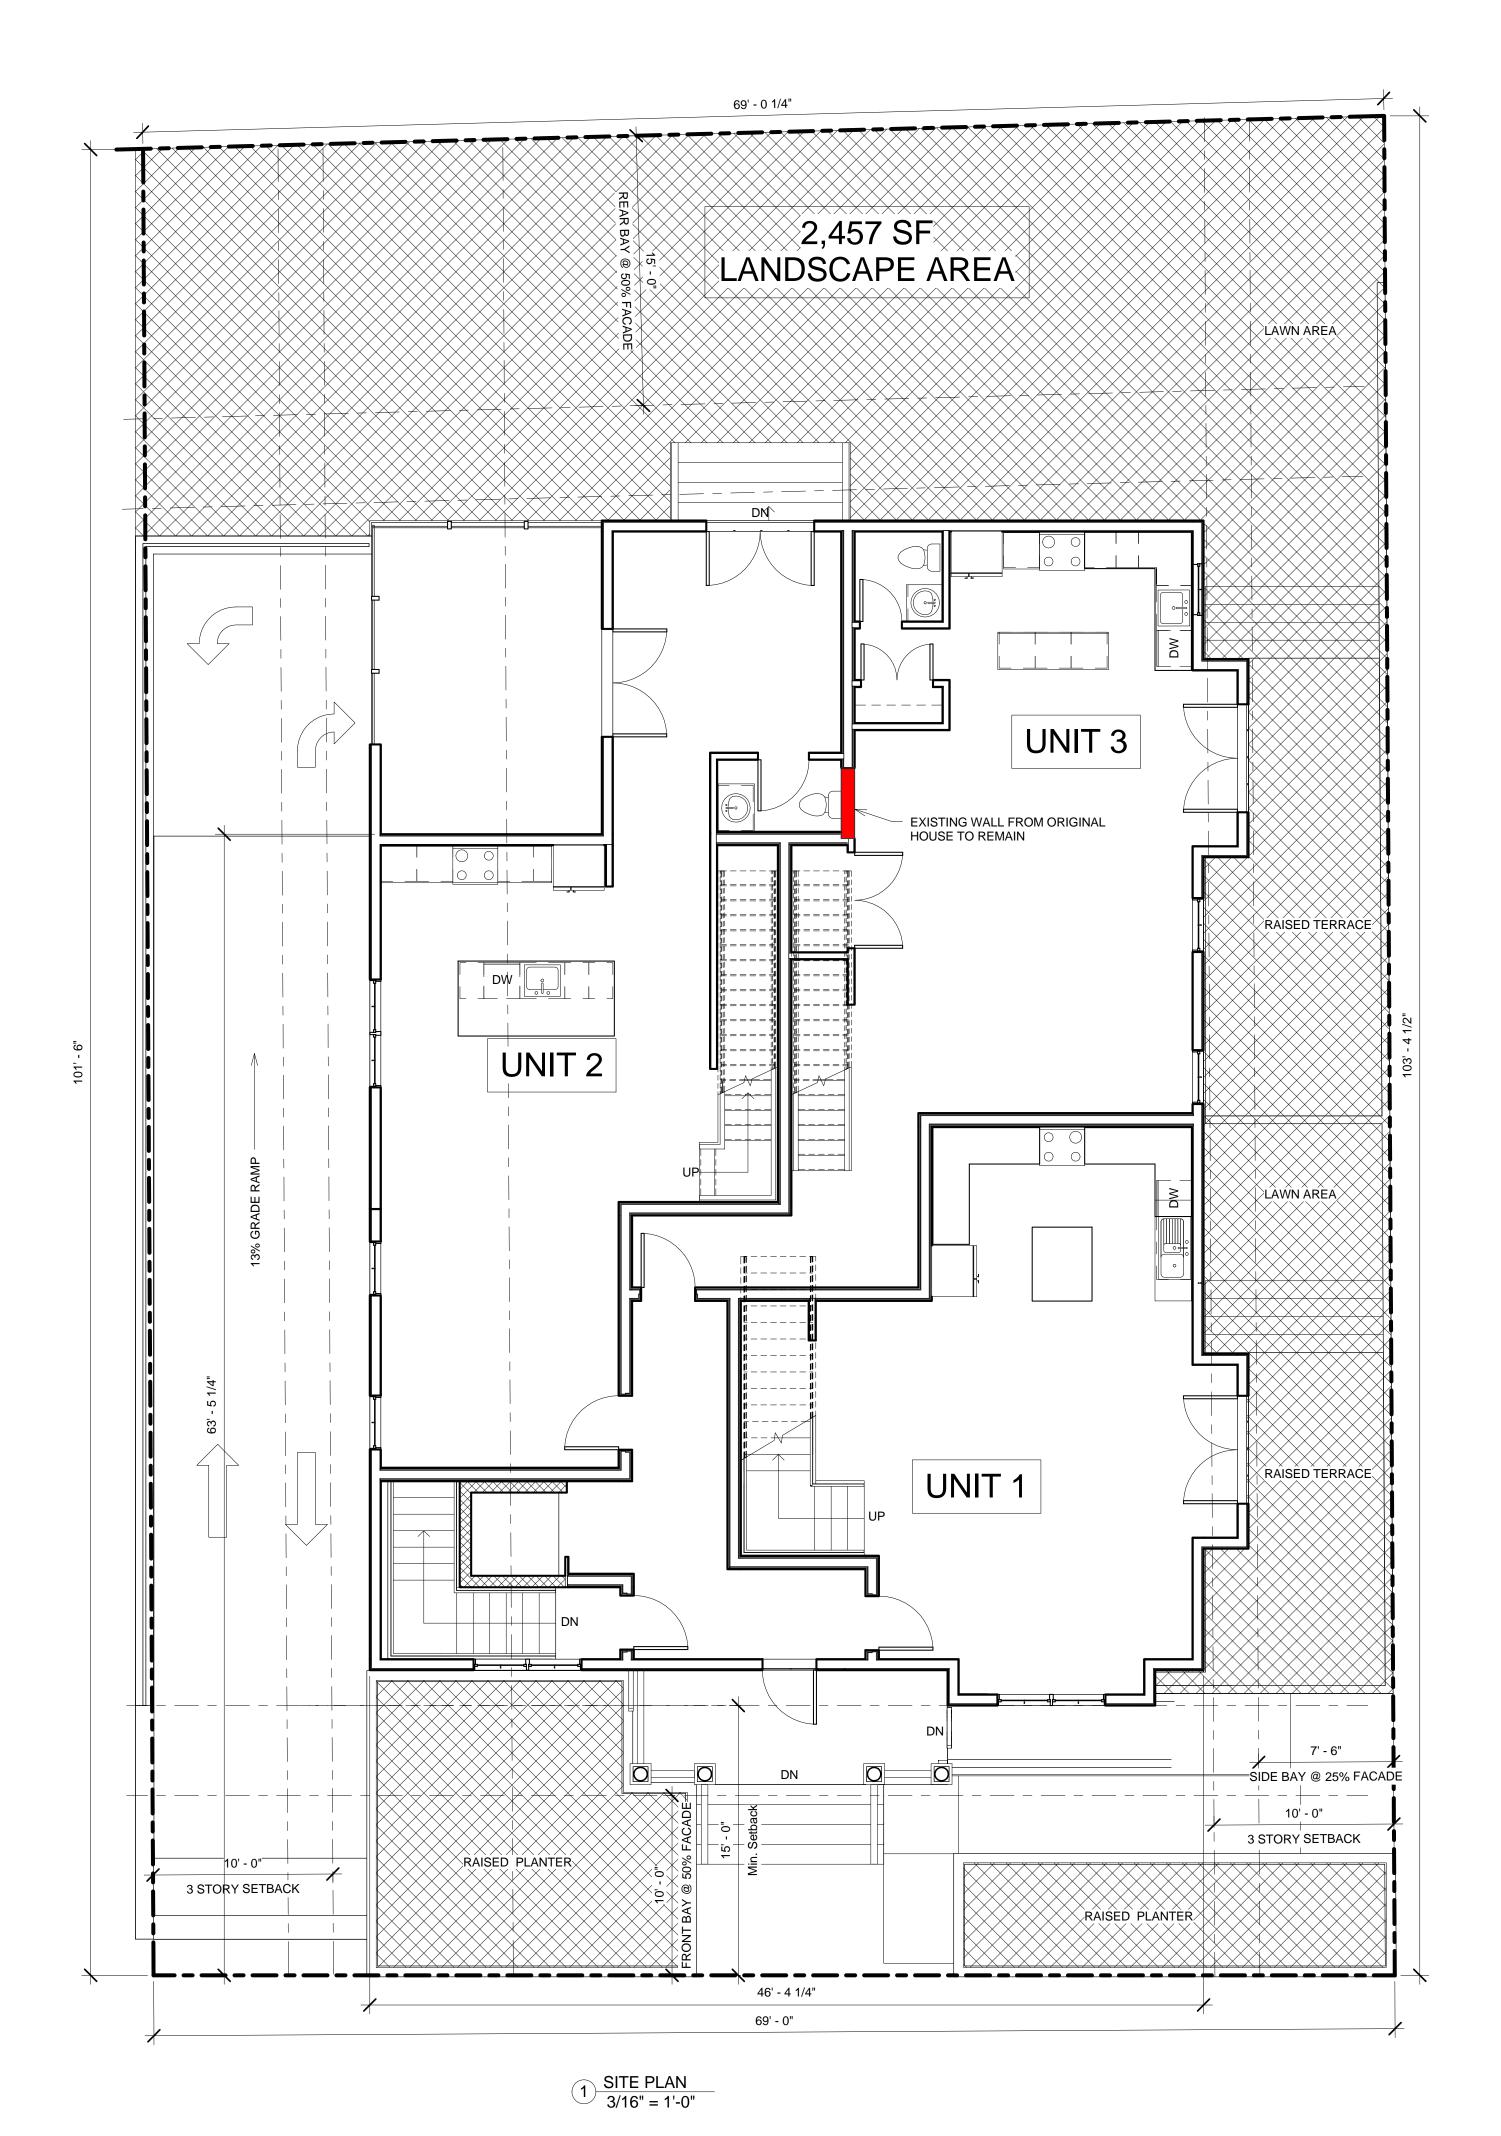

DOVER STREET RESIDENCES

PROJECT ADDRESS

88 DOVER STREET SOMERVILLE MA

CLIENT

Sing Cheung

ARCHITECT KHALSA DESIGN INC.



17 IVALOO STREET SUITE 400 SOMERVILLE, MA 02143 TELEPHONE: 617-591-8682 FAX: 617-591-2086

CONSULTANTS:

REGISTRATION



Project	number	13007
Date		10-14-15
Drawn	ру	WC
Checke	d by	KDI
Scale		1/4" = 1'-0"
REVIS	SIONS	
No.	Description	Date

BASEMENT PLAN

A-100 DOVER STREET RESIDENCES

DOVER STREET

DOVER STREET RESIDENCES

PROJECT ADDRESS

88 DOVER STREET SOMERVILLE MA

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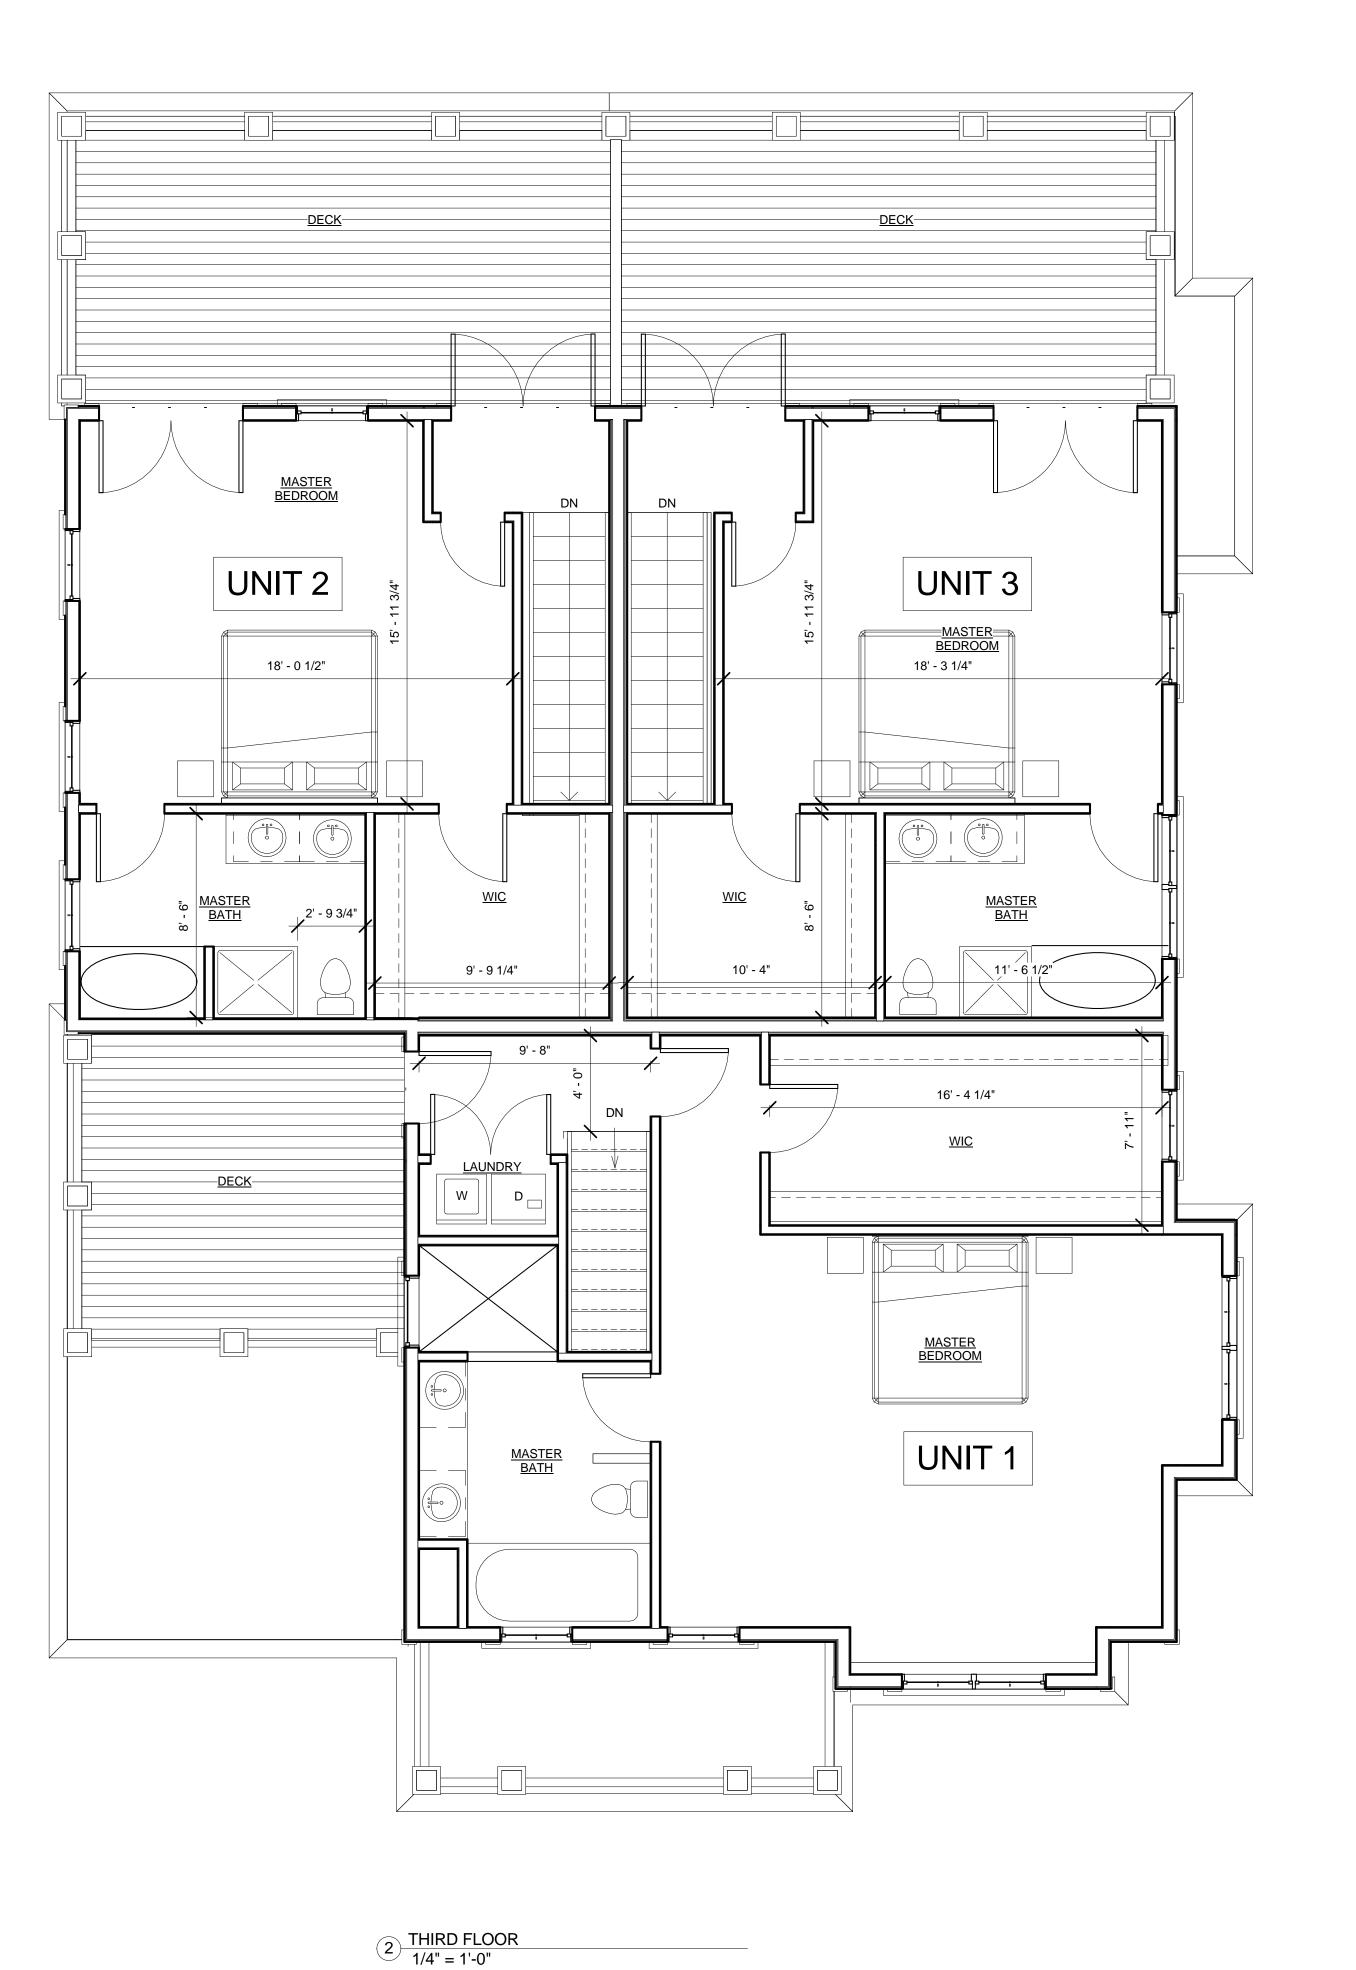
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Project number	13007	
Date	10-14-15	
Drawn by	WC/CMH	
Checked by	KDI	
Scale	1/4" = 1'-0"	
REVISIONS		


REVISIONS			
Description	Date		

FIRST FLOOR PLAN

DOVER STREET RESIDENCES

1) FIRST FLOOR LEVEL 1/4" = 1'-0"



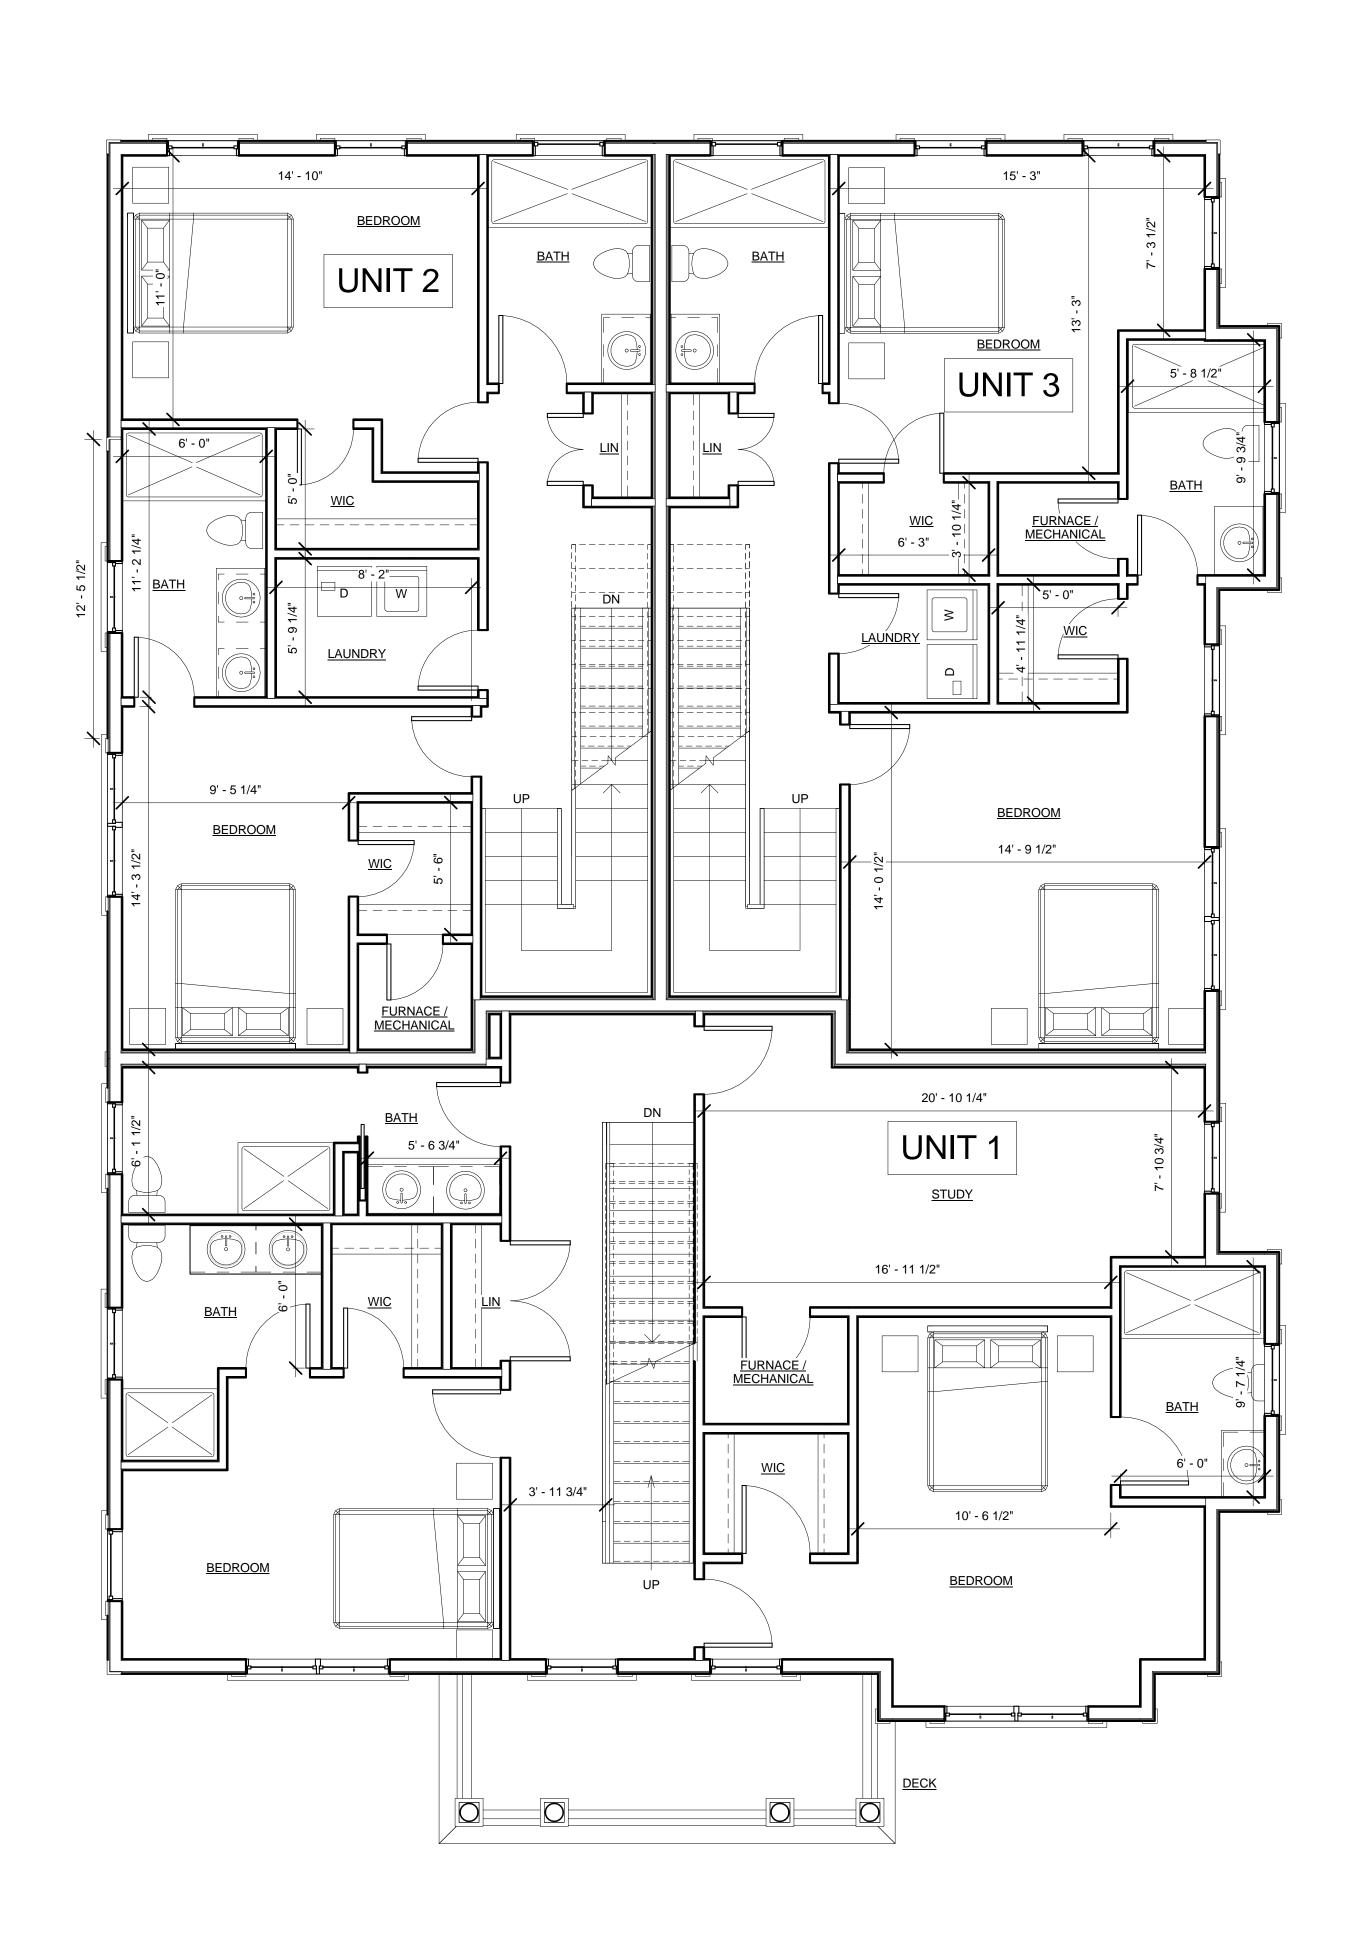

DOVER STREET RESIDENCES

PROJECT ADDRESS

88 DOVER STREET SOMERVILLE MA

CLIENT

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KHALSA DESIGN INC.

ARCHITECT



17 IVALOO STREET SUITE 400 SOMERVILLE, MA 02143 TELEPHONE: 617-591-8682 FAX: 617-591-2086

CONSULTANTS:



Project nu	mber	13007	
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Drawn by		WC/ CMH	
Checked b	ру	KDI	
Scale		1/4" = 1'-0"	
REVISION	ONS		
No.	Description	Date	

SECOND & THIRD LEVELS

> **A-102** DOVER STREET RESIDENCES

DOVER STREET RESIDENCES

PROJECT ADDRESS

88 DOVER STREET SOMERVILLE MA

Sing Cheung

KHALSA DESIGN INC.



17 IVALOO STREET SUITE 400 SOMERVILLE, MA 02143 TELEPHONE: 617-591-8682 FAX: 617-591-2086

CONSULTANTS:



13007 10-14-15 WC/ CMH KDI 3/16" = 1'-0" Project number

EVISIONS		
Description	Date	

EXTERIOR ELEVATIONS

A-300 DOVER STREET RESIDENCES



17 IVALOO STREET SUITE 400 SOMERVILLE, MA 02143 TELEPHONE: 617-591-8682 FAX: 617-591-2086

CONSULTANTS:

REGISTRATION



Project number	13007
Date	10-14-15
Drawn by	MT
Checked by	KDI
Scale	

REVISIONS		
No.	Description	Date

PERSPECTIVES

A-301

DOVER STREET RESIDENCES







1 Copy of {3D}







5 3D View 3

4 Copy (4) of {3D}

CLIENT

Sing Cheung

ARCHITECT
KHALSA DESIGN INC.



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CONSULTANTS:

REGISTRATION

REVISIONS







EXISTING

13007 10-14-15 CMH KDI

A-303

DOVER STREET RESIDENCES

Renderings